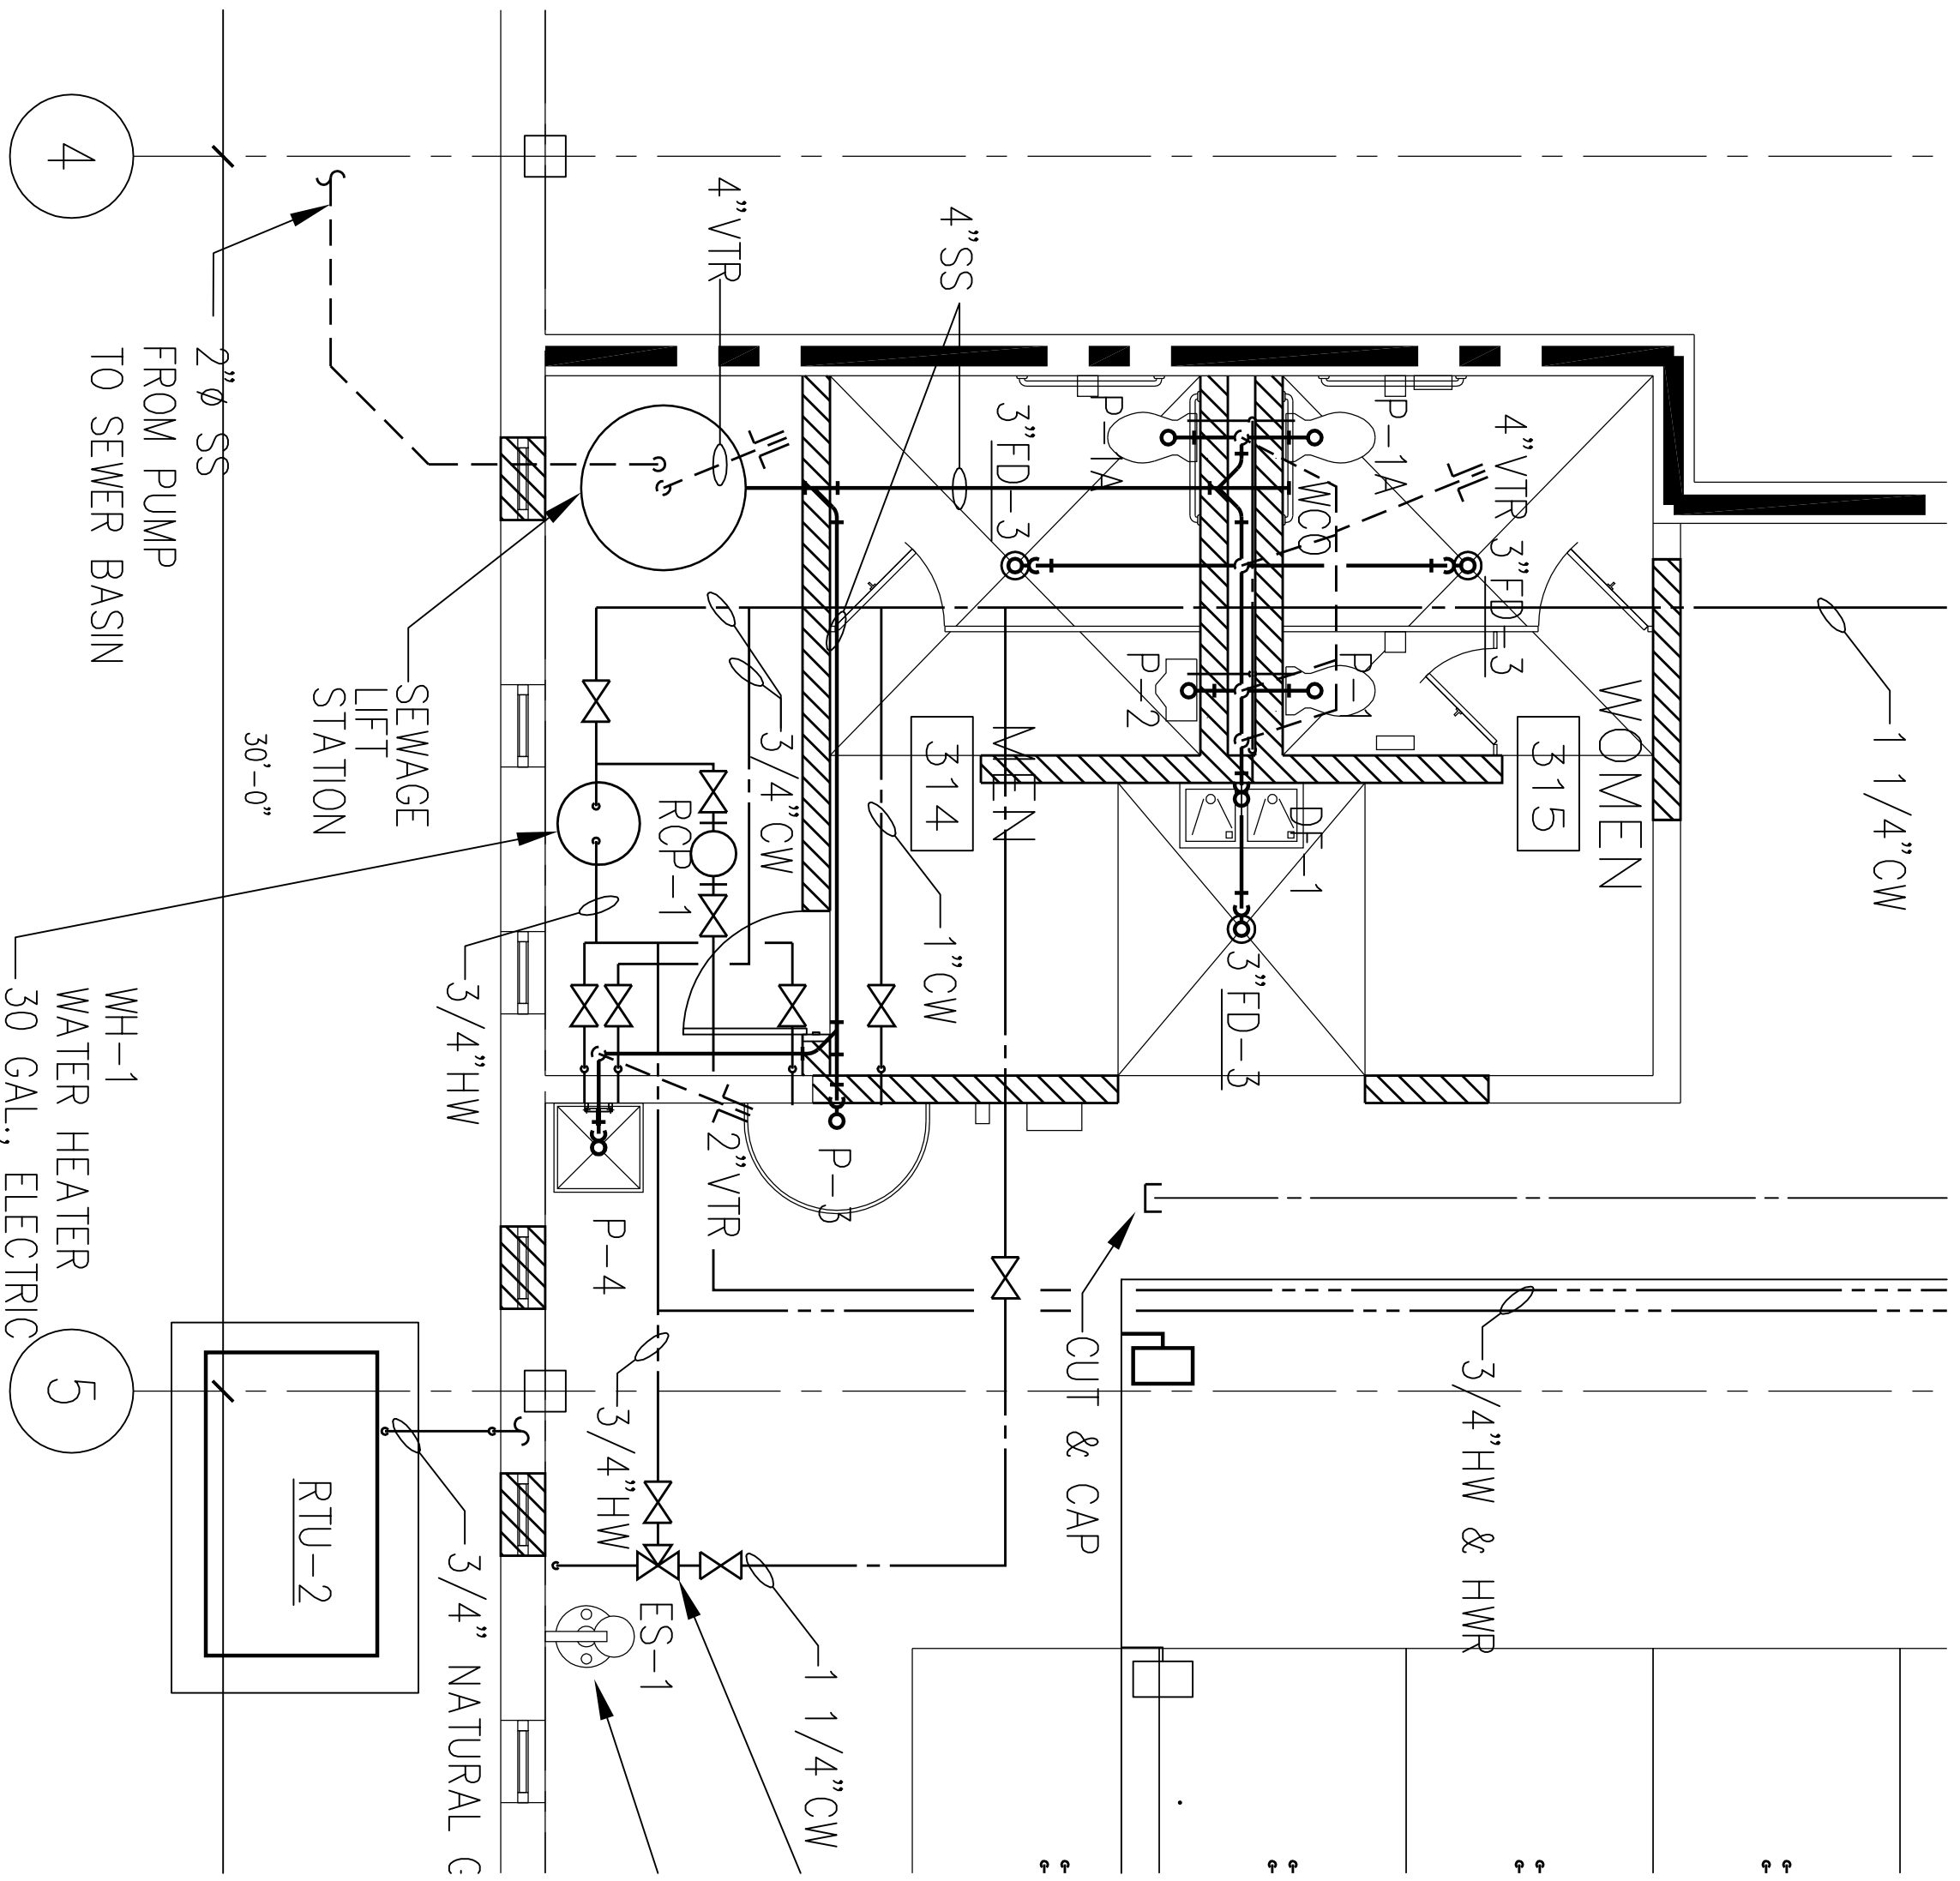


FIRST FLOOR PLAN
1/8" = 1'-0"

MT
PI-1



ENLARGED BATHROOM PLAN
1/4" = 1'-0"

AT
PI-2

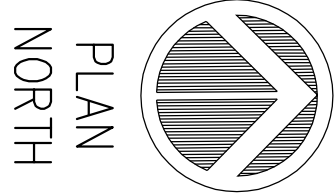
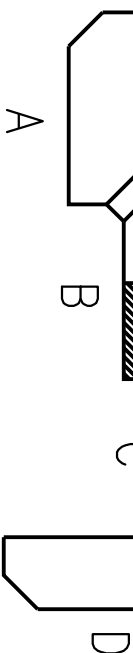
FLOOR PLAN GENERAL NOTES:

- 1) ROUTE 3/2" GAS ON ROOF TO OWNER FURNISHED RTU-1 & 2.
- 2) COORDINATE WITH HVAC CONTRACTOR FOR ROUTING OF GAS LINES AND UTILIZING DUCT SUPPORTS FOR HANGING GAS PIPING AS NEEDED.
- 3) ROUTE SANITARY WASTE LINES FROM NEW PLUMBING FIXTURES TO NEW LIFT STATION. ROUTE 2" LIFT STATION DISCHARGE TO SEWER BASIN OUTSIDE BUILDING.
- 4) ROUTE 1" COMPRESSED AIR PIPING TO EACH DUST COLLECTOR

KEYNOTE LEGEND:

- (KN-1) WELDING BOOTHS - ROUTE 3/4" DROPS OF ARGON & MIXED GAS. PROVIDE REGULATORS AND ISOLATION VALVES.
- (KN-2) OWNER FURNISHED RTU'S. COORDINATE WITH HVAC CONTRACTOR FOR ROUTING NATURAL GAS LINE FROM ROOF TO UNITS.
- (KN-3) CUTTING STATIONS - ROUTE 3 EA. 3/4" DROPS OF ACETYLENE, O2 WITH REGULATORS AND ISOLATION VALVES.
- (KN-4) CUTTING TABLES TABLE- ROUTE 3/4" DROPS OF ACETYLENE & O2 DOWN TO TABLES. PROVIDE REGULATORS AND ISOLATION VALVES.
- (KN-5) FUTURE WELDING BOOTHS
- (KN-6) EACH GAS SYSTEM SHALL HAVE A BULK TANK, REGULATORS, ISOLATION VALVES AND GAUGES

COMPLEX KEY PLAN

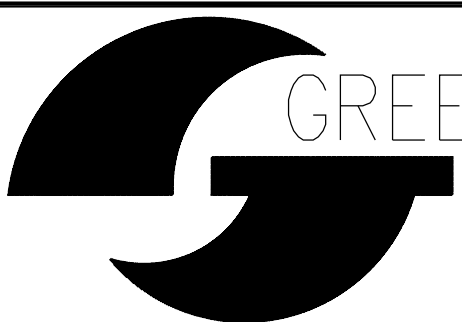


P1-1

PLUMBING
FLOOR PLAN

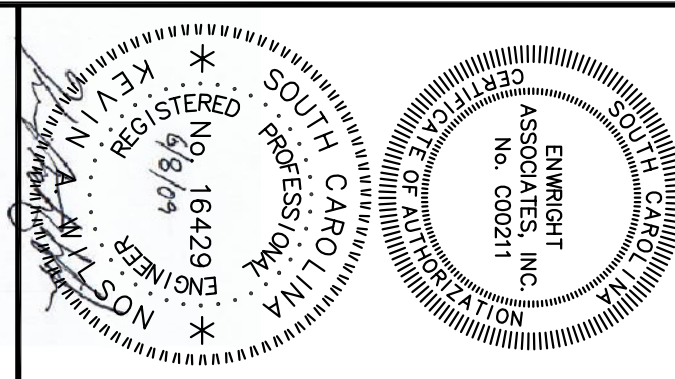
NO.	DATE	REVISION

JOB NO.	09GTECWELDING	DATE	6/15/99	12/22/04	DRAWN BY	T. KIRBY
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